
YOUTH / COMMUNITY CENTRE REFURBISHMENT

HAY PARK MORGAN STREET, HAY, NSW, 2711

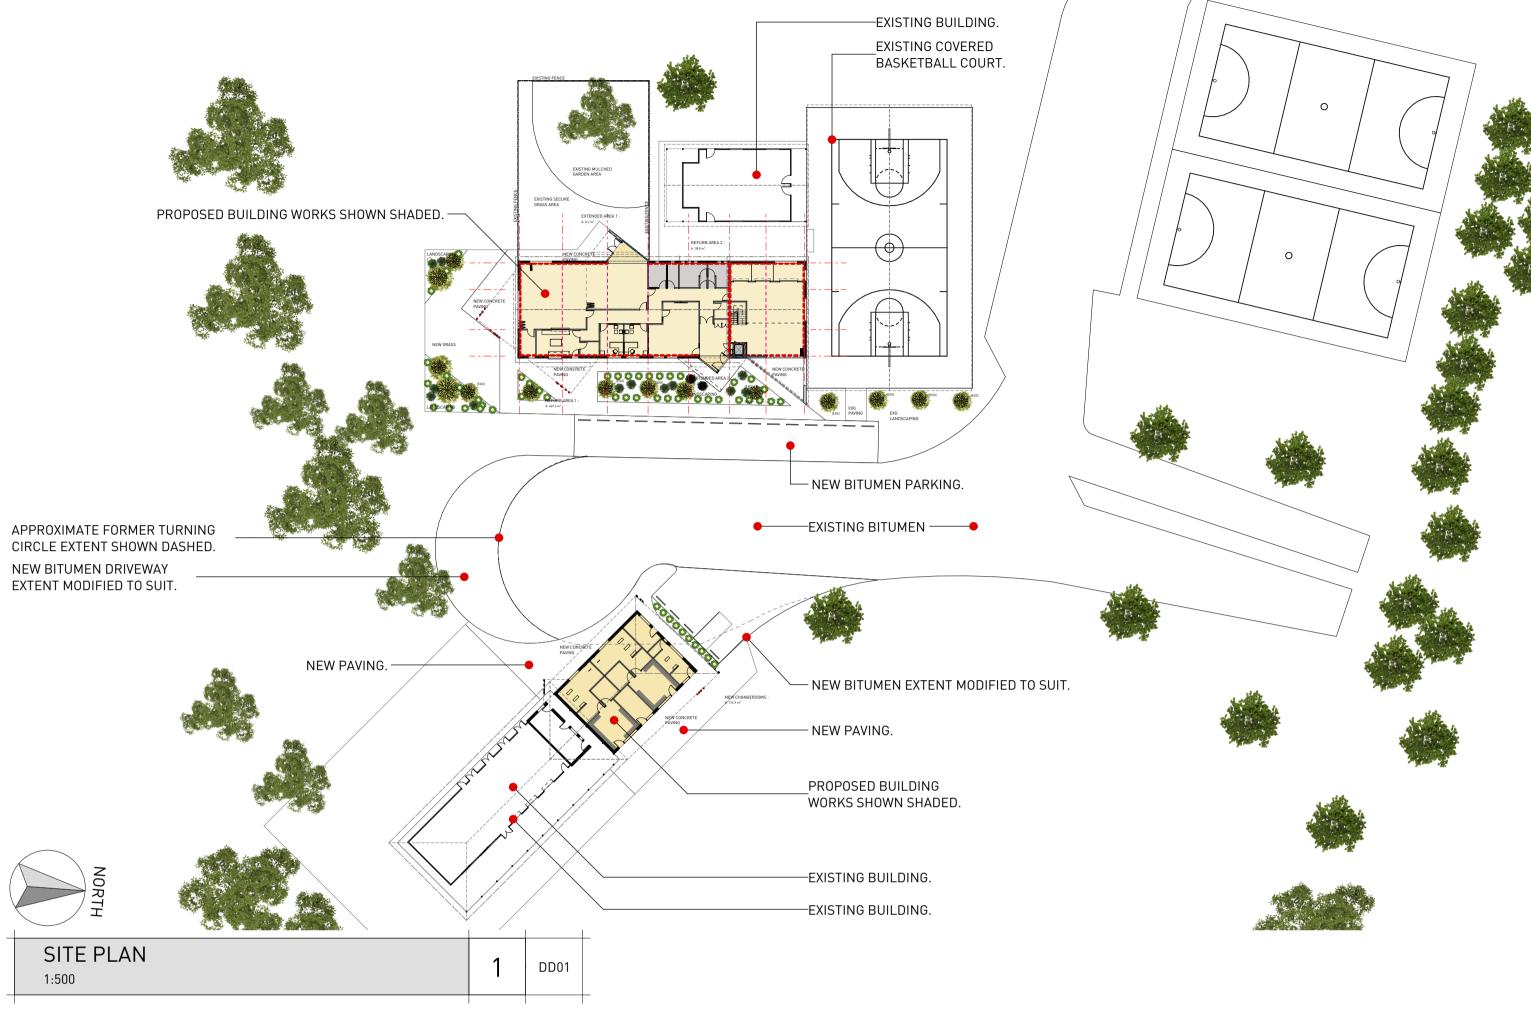







LOCATION PLAN:



SUBJECT SITE: HAY PARK MORGAN STREET, HAY, NSW, 2711.

SITE NOTES:

- STORMWATER DIRECTED TO KERB ONSITE RETENTION BASINS TO THE SATISFACTION OF THE RESPONSIBLE AUTHORITY.
- 2. PROVIDE INSPECTION OPENINGS EVERY 9m OF RUN AND CHANGE IN DIRECTION
- 3. 100MM DIA. DOWNPIPES D.P AS SPECIFIED
- STRATCO EDGE GUTTER TO MANUFACTURERS DETAILS & 100x75 SQUARE DOWNPIPES (SELETCED COLORBOND). CONNECT TO RAIN WATER TANKS WHERE APPLICABLE.
- STORMWATER DETENTION AS PER CONSULTANTS DESIGN REFER TO ATTACHED DOCUMENTS FOR DESIGN & SPECIFICATIONS.
- FINISHED FLOOR LEVELS TO BE VERIFIED BY AN ENGINEER
- COMPACTED FILL. FILL TO BE COMPACTED IN ACCORDANCE WITH AS2870 & TO BE TESTED BY AN APPROVED ENGINEER.
- DIGNIFIED ACCESS IN ACCORDANCE WITH A.S 1428.1 2009. GRADIENT AS PER ENGINEERS DESIGN IN ACCORDANCE WITH A.S 1428.1 2009

AREAS SCHEDULE:

BUILDING AREAS :	
ZONE:	AREA (m2)
EXTENDED AREA 1 :	8.2
EXTENDED AREA 2 :	4.2
NEW CHANGEROOMS :	174.9
REFURB AREA 1 :	449.4
REFURB AREA 2 :	38.8
	675.5 m ²



PERSPECTIVE - VIEW 1

DD01

LANDSCAPE SCHEDULE:					
	TYPE		BOTANICAL NAME		
A	EXISTING	TREE	EXISTING	3-10M	
В	PROPOSED	TREE	TO MATCH EXG FRONT TREES	3-4M	
C	MAT RUSH	HERB	LONMONDRA LONGIFOLIA	1M	
D	SPREADING FLAX LILY	TUFTING PLANT	DIANELLA REVOLUTA	1M	
CPV	PAVING (CONCRETE)	SEALED AREAS	CONC TO ENG DETAILS.	0	
BN	BITUMEN	SEALED AREAS	BITUMEN TO ENG DETAILS	0	
ВС	BARK CHIP BEDS	BEDS	MULTI-BARK MULCH	0	
GR	TURFED AREAS	GRASS	SOFT LEAF BUFFALO	0	

SHEET No DD01 Project YOUTH / COMMUNITY CENTRE REFURBISHMENT Client HAY SHIRE COUNCIL Location HAY PARK MORGAN STREET, HAY, AS SHOWN | Issue Date:

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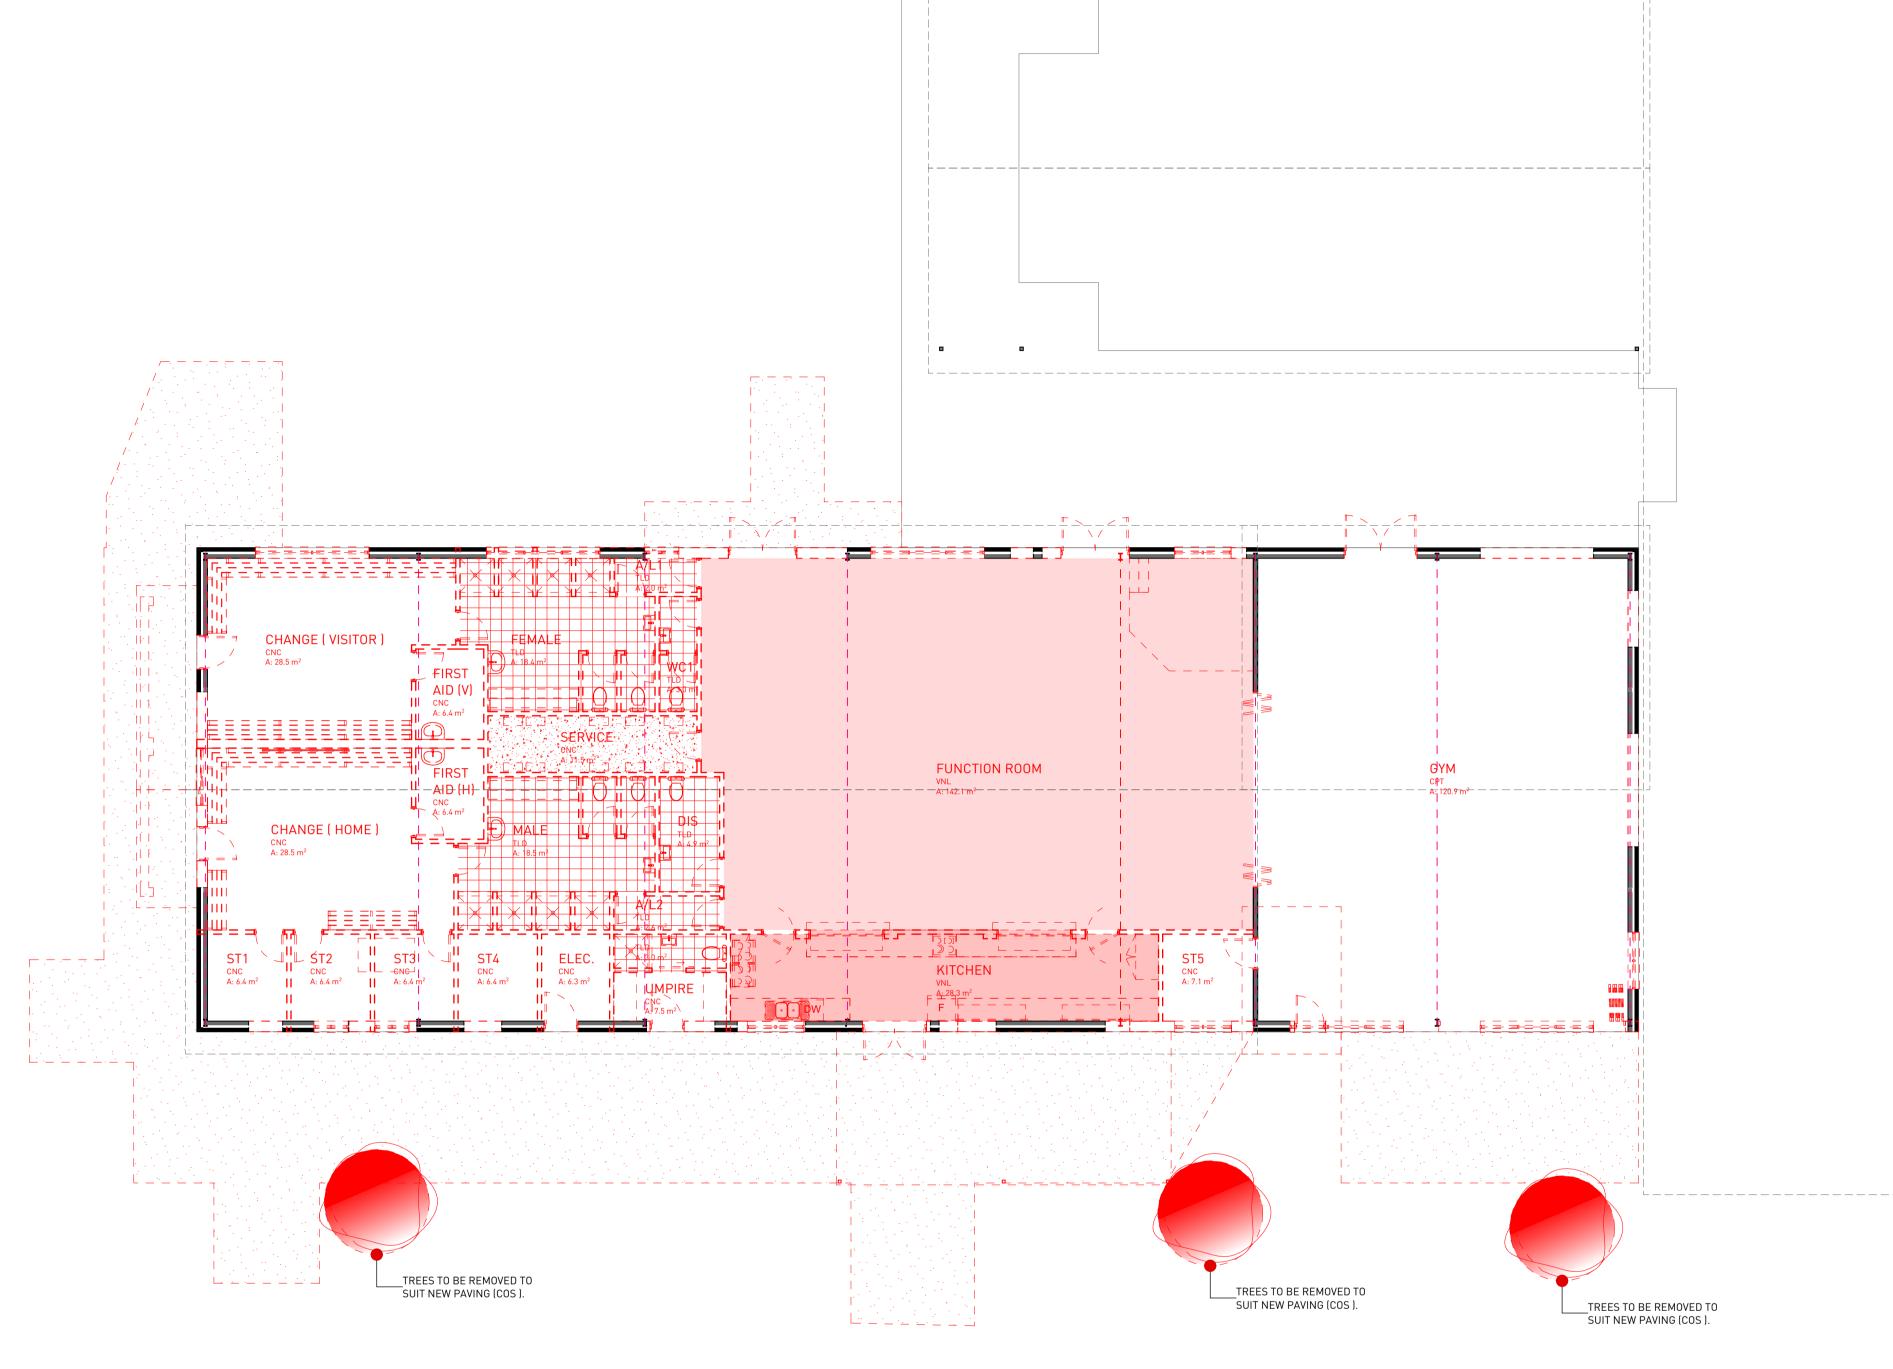



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REGISTERED PRACTITIONERS - ANDREW NAIRN - A 15202
LARRY CAVALLARO - DP 1889

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DEMOLITION PLAN
1:100

: WALLS SHOWN DASHED TO BE DEMOLISHED : WINDOWS SHOWN DASHED TO BE DEMOLISHED : DOORS SHOWN DASHED TO BE DEMOLISHED : WALLS SHOWN SOLID TO REMAIN SERVICES: SEAL OFF ALL SERVICES AS REQUIRED CAUSED BY DEMOLITION TO AUTHORITIES APPROVAL. CEILING: REMOVE ALL CEILINGS

DEMOLITION NOTES:

PROTECTION:

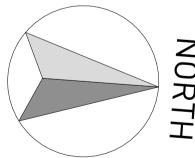SAFE ACCESS AND EGRESS FROM BUILDINGS SHALL BE MAINTAINED AT ALL TIMES.

NO DEMOLITION ACTIVITY SHALL CAUSE DAMAGE TO, OR AFFECT THE STRUCTURAL INTEGRITY OF ADJOINING BUILDINGS.

THE EFFECTS OF VIBRATION OR CONCUSSION EQUIPMENT SHALL BE MINIMIZED TO AVOID DISRUPTION TO ADJOINING BUILDINGS.

WEATHERPROOFING OF ADJOINING BUILDINGS, DURING DEMOLITION SHALL BE CARRIED OUT, IF REQUIRED.

NO BURNING OF DEMOLITION MATERIALS WILL BE ALLOWED ON SITE.

DUST CONTROL SHALL BE MAINTAINED BY HOSING DOWN, OR SIMILAR METHODS, TO AVOID EMISSIONS FROM THE SITE.

NOISE SHALL BE MINIMISED, BY THE SELECTION OF APPROPRIATE DEMOLITION METHODS.
PRECAUTIONS SHALL BE TAKEN TO MINIMISE THE SPREADING OF MUD AND DEBRIS ONTO THE PUBLIC ROADS.
NO DEMOLITION REFUSE OR WASTE SHALL BE ALLOWED TO ENTER THE SEWER OR STORMWATER SYSTEMS.
NO DEMOLITION ACTIVITY SHALL CAUSE DAMAGE TO OR AFFECT THE STRUCTURAL STABILITY OF BUILDINGS THAT ARE TO BE RETAINED ON SITE. PLANNING AND EXECUTION THE WORK SHALL BE EXECUTED BY COMPETENT PERSONS WITH DUE REGARD TO

RETAINED ON SITE. PLANNING AND EXECUTION THE WORK SHALL
BE EXECUTED BY COMPETENT PERSONS WITH DUE REGARD TO
SAFE WORK PRACTICES AND IN ACCORDANCE WITH THE "WORK
PLAN" (COPY KEPT ON SITE).

• PROVIDE TEMPORARY HOARDING TO ANY OPEN/EXPOSED
BOUNDARY OF THE NOMINATED SITE TO PREVENT UNAUTHORIZED
ENTRY TO THE SITE.

• IF WALLS OR ROOFS ARE OPENED FOR ALTERATIONS AND

ENTRY TO THE SITE.

• IF WALLS OR ROOFS ARE OPENED FOR ALTERATIONS AND ADDITIONS OR THE SURFACES OF ADJOINING BUILDINGS ARE EXPOSED, PROVIDE TEMPORARY COVERS TO PREVENT WATER PENETRATION. PROVIDE COVERS TO PROTECT EXISTING PLANT AND EQUIPMENT AND MATERIALS INTENDED FOR REUSE.

• PROVIDE DUST-PROOF SCREENS, BULKHEADS AND COVERS TO PROTECT EXISTING FINISHES AND THE IMMEDIATE ENVIRONMENT FROM DUST & DEBRIS.

DEMOLITION:

• ALL DEMOLITION SHALL BE SUPERVISED BY A COMPETENT PERSON, IN ACCORDANCE WITH AS2601 AND ALL APPLICABLE "CODES OF PRACTICE" • THE STRUCTURE AND ALL ITS COMPONENTS SHALL BE MAINTAINED IN A STABLE AND SAFE CONDITION AT ALL TIMES. • TEMPORARY BRACING, GUYS AND SHORING SHALL BE USED TO ENSURE STABILITY. OPENINGS IN EXISTING WALLS AND FLOORS SHALL BE BOARDED OR PROTECTED TO PREVENT PERSONS FALLING TO A LOWER LEVEL. • SUSPENDED FLOORS SHALL NOT BE LOADED BY MACHINERY OR EXCESSIVE DEMOLISHED MATERIAL/RUBBLE.

• ALL DEMOLITION SHALL BE CARRIED OUT BY SEQUENTIAL METHODS AS OUTLINED IN CL.2.2 IN AS2601. AT NO TIME WILL "INDUCED COLLAPSE" METHODS BE USED ON THE SITE. ALL FOOTINGS AND FOUNDATIONS CONNECTED TO ADJOINING BUILDING WALLS SHALL BE ISOLATED BY CONCRETE CUTTING PRIOR TO DEMOLITION OF FOOTING SYSTEMS. A DEMOLITION CHECKLIST SHALL BE USED, IN ACCORDANCE WITH APPENDIX A AS2601, TO ASSIST IN THE SAFE DEMOLITION OF ALL BUILDINGS. ALL EXCAVATED MATERIAL IS TO BE REMOVED FROM SITE AS IT IS PRODUCED AN NO RUBBISH OR SURPLUS OF EXCAVATED MATERIAL MATERIALS SPECIFIED OR INDICATED ON THE DRAWINGS TO BE INCORPORATED INTO ANY NEW WORKS SHALL BE STORED AND HANDLED SO AS NOT TO BE DAMAGED. NO EXISTING TREES OR VEGETATION ARE TO BE REMOVED UNLESS OTHERWISE NOTED. • ALL STUMPS, ROOTS & OTHER OBJECTIONABLE MATERIALS WITHIN THE WORKS AREA SHALL BE REMOVED TO A DEPTH OF 400MM BELOW EXISTING GROUND LEVEL IN AREAS TO BE FILLED
AND 400MM BELOW THE BOTTOM OF THE PROPOSED FORMATION IN AREAS OF CUT. UNLESS LOCATED IN AN AREA WHICH IS REQUIRED TO BE EXCAVATED TO A LOWER LEVEL, ALL HOLES IN THE GROUND AS A RESULT OF GRUBBING SHALL BE COMPACTED TO A DEGREE CONSISTENT WITH THE INTENDED USE OF THE AREA. • IN AREAS OTHER THAN FOR BUILDINGS AND PAVEMENTS, THE TOP 225MM OF FILL SHALL BE LOOSE TOPSOIL.

PRELIMINARIES:

 DURING PLANNING AND EXECUTION OF DEMOLITION WORK, APPROPRIATE ACTIONS SHALL BE TAKEN TO PREVENT DEMOLISHED MATERIALS FROM FALLING FREELY OUTSIDE OF THE DEMOLITION AREA.

THE SAFETY OF ALL STRUCTURES, ETC. IS THE ENTIRE RESPONSIBILITY OF THE BUILDER.
THE ENTIRE SITE SHALL HAVE A SECURE CYCLONE FENCE (2.4M

HIGH) INSTALLED TO PREVENT UNAUTHORIZED ACCESS TO THE

THE FENCING SHALL DISPLAY "DANGER! DEMOLITION WORKS IN PROGRESS" OR SIMILAR, TO WARN THE PUBLIC. SCAFFOLDING REQUIRED FOR DEMOLITION SHALL BE HEAVY DUTY, COMPLYING WITH AS1576. AND SHALL ENCLOSE THE RELEVANT WORK AREA, BE STRONG ENOUGH TO WITHSTAND THE IMPACT OF RUBBLE AND BE MAINTAINED AND INSPECTED REGULARLY.

NO DEMOLISHED MATERIAL SHALL BE STORED ON THE SCAFFOLDING.

BEFORE COMMENCEMENT OF ANY STRIPPING OR DEMOLITION, AN INSPECTION OF ANY POSSIBLE HAZARDOUS MATERIALS SHALL BE CARRIED OUT, PRIOR TO COMMENCEMENT OF WORKS.

IF HIGH TEMPERATURE CUTTING OR WELDING IS TO BE CARRIED OUT, THE PRECAUTIONS IN AS1674 SHALL BE OBSERVED.

ANY MATERIALS PAINTED IN LEAD-BASE PAINTS REQUIRING CUTTING OR WELDING, COULD CAUSE NOXIOUS FUMES AND THE APPROPRIATE RESPIRATORY EQUIPMENT SHALL BE PROVIDED TO ALL WORKERS IN THE AREA.

TEMPORARY ELECTRICAL INSTALLATIONS SHALL COMPLY WITH AS3012.
ALLOW FOR CUTTING OFF AND/OR SEALING OFF OF EXISTING

SERVICES WHERE REQUIRED.

• ALL SERVICES TO BE CHECKED ON SITE PRIOR TO ANY WORKS & ALLOWANCE MUST BE MADE FOR THE RELOCATION OR TERMINATION OF EXISTING SERVICES. ARRANGE WITH THE APPROPRIATE AUTHORITIES

FOR THIS WORK TO BE CARRIED OUT AND PAY ALL FEES RELATED THEREWITH.

• GIVE NOTICE IMMEDIATELY HAZARDOUS MATERIALS OR

CONDITIONS ARE FOUND, INCLUDING THE FOLLOWING: ASBESTOS OR MATERIAL CONTAINING ASBESTOS, FLAMMABLE OR EXPLOSIVE LIQUIDS OR GASES, TOXIC INFECTIVE OR CONTAMINATED MATERIALS, RADIATION OR RADIO-ACTIVE MATERIALS, NOXIOUS OR EXPLOSIVE CHEMICALS, TANKS OR OTHER CONTAINERS WHICH HAVE BEEN USED FOR STORAGE OF EXPLOSIVE/TOXIC/INFECTIVE OR CONTAMINATED SUBSTANCES.

BUILDINGS, PRIOR TO ANY WORKS COMMENCING.

• REPORTS TO BE SENT TO SUPERINTENDENT.

• PROTECTION NOTICES SHALL BE ISSUED AND RETURNED FROM ADJOINING BUILDINGS, PRIOR TO WORKS COMMENCING.

• DILAPIDATION REPORTS SHALL BE CARRIED OUT ON ADJOINING

ALL COUNCIL HOARDING PERMITS AND TRAFFIC CONTROL
 MEASURES SHALL BE UNDERTAKEN TO PROTECT PUBLIC AND
 ALLOW SAFE VEHICLE ACCESS TO STREET / AVENUE
 EXPLOSIVES ARE NOT TO BE USED.

 IF ANY WALL OR ROOF IS OPENED FOR ALTERATIONS. PROVIDE

IF ANY WALL OR ROOF IS OPENED FOR ALTERATIONS, PROVIDE SECURITY AGAINST UNAUTHORIZED ENTRY TO THE BUILDING.
 THE SITE SHALL BE SECURED AT ALL TIMES AND PROVISION FOR READY ACCESS TO THE SITE BY EMERGENCY SERVICES, SHALL BE MAINTAINED.




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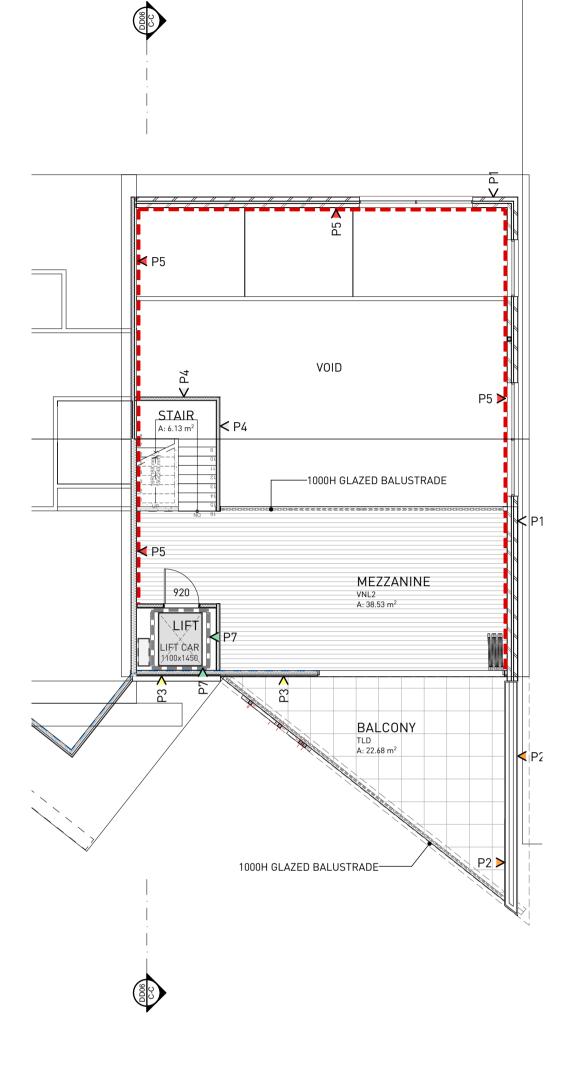


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MEZZANINE DD03 1:100

> SHEET No DD03 Project | YOUTH / COMMUNITY CENTRE REFURBISHMENT Client | HAY SHIRE COUNCIL Location | HAY PARK MORGAN STREET, HAY, NSW, 2711 Issue Date: AS SHOWN Rev No: 28/03/2024

PROJECT No.

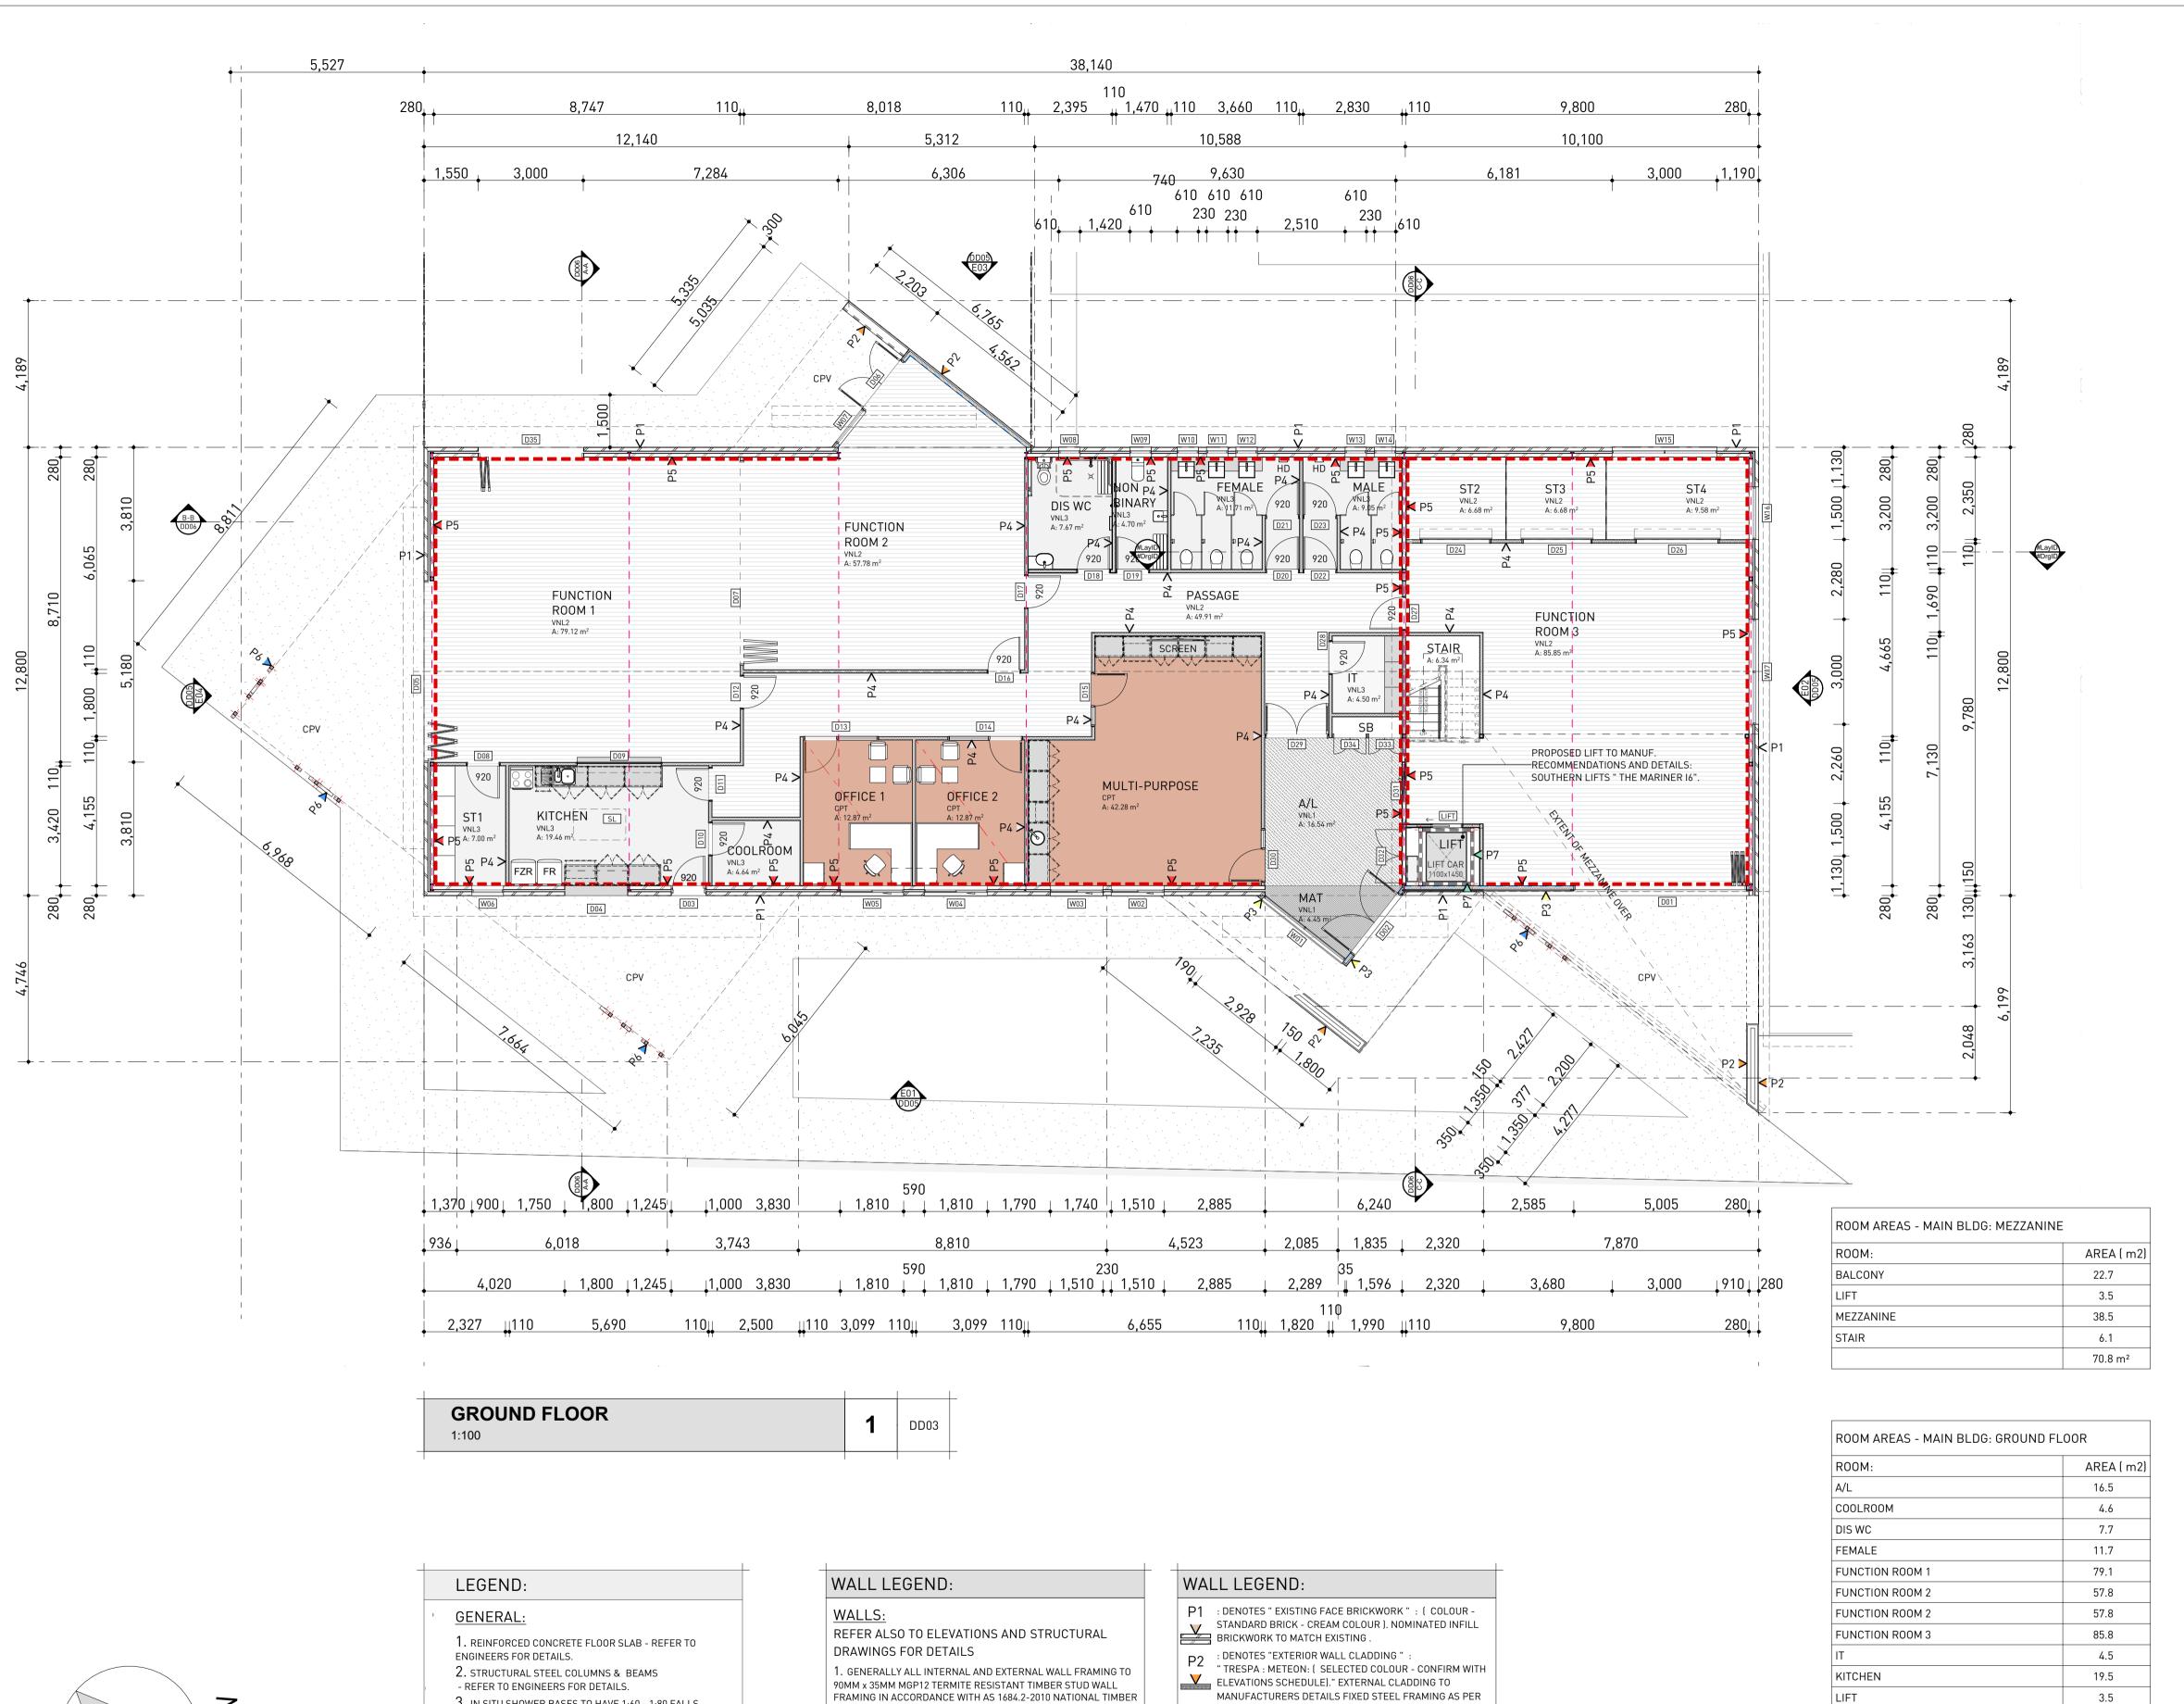

REGISTERED PRACTITIONERS - ANDREW NAIRN - A 15202 LARRY CAVALLARO - DP 1889

HITECTURE D/I

WITH ELEVATIONS SCHEDULE)." EXTERNAL CLADDING TO TO SUIT INTERNAL LINING AS SPECIFIED. P4 : DENOTES "INTERNAL WALL" : R2.5 ACOUSTIC INSULATION AS SPECIFIED / PLASTERBOARD LINING INTERNALLY TYPICAL OR CEMENT SHEET TO WET AREAS. P5 : DENOTES "LINING ADDED TO EXG WALLFACE" : PLASTERBOARD LINING (OR CEMENT SHEET TO WET AREAS) ON WALL BATTENS FIXED TO INTERNAL MASONRY WALL FACE. : DENOTES "ANGLE STRUCTURAL POSTS" : P6 VARIOUS ANGLES GROUP OF POSTS TO ENG. DETAILS. - SELECTED COLOUR - CONFIRM WITH ELEVATIONS SCHEDULE. P7 : DENOTES "LIFT WALL" : STRUCTURAL WALL / LINING TO

- REFER TO ENGINEERS FOR DETAILS. 3. IN SITU SHOWER BASES TO HAVE 1:60 - 1:80 FALLS 4. SKIRTINGS & ARCHITRAVES : SKIRTINGS NOMINALLY 100MM HIGH MDF (PAINT FINISH) WITH SHADOWLINE ABOVE. ARCHITRAVES TO HAVE SHADOWLINE AT JAMBS AS DETAILED.

FIRE HAZARD INDICES: FIRE HAZARD PROPERTIES OF LININGS & COVERINGS TO COMPLY WITH CLAUSE C1.10 OF THE BCA

FLOOR FINISHES:

⊕FT FLOOR TRAP SHS STEEL POST TO ENG DETAILS.

CPT SELECTED CARPET TILES VNL1 SELECTED SHEET VINYL -TYPE 1 (EXPONA DESIGN: BLACK TREADPLATE 8122)

VNL2 SELECTED SHEET VINYL -TYPE 2 (TIMBERLOOK) VNL3 SELECTED SHEET VINYL -TYPE 3 TLD SELECTED EXTERIOR GRADE TILE CPV CONCRETE PAVING - TO ENG DETAILS

(SELECTED PEBBELCRETE FINISH)

FRAMING IN ACCORDANCE WITH AS 1684.2-2010 NATIONAL TIMBER FRAMING CODE & THE BUILDING CODE OF AUSTRALIA. ENSURE REVEALS SUIT WIDTH OF WALLS. PROVIDE NOGGINGS FOR ALL FIXTURES AND FITTINGS.

2. CSR GYPROCK 10MM FLUSH PLASTERBOARD WALL LINING OR SIMILAR APPROVED (UNO).

3. 6MM VILLABOARD WALL LINING INTERNALLY TO WET AREAS TO MANUFACTURERS RECOMMENDATIONS (UNO). 4. WET AREAS TO BE WATERPROOFED IN ACCORDANCE WITH AS3740.

NOTE: 'BRACING OF STRUCTURE TO COMPLY WITH THE REQUIREMENTS AS1684.2'.

MANUFACTURERS DETAILS FIXED STEEL FRAMING AS PER ENG DETAILS & INSULATION AS SPECIFIED / STUD FRAMING TO SUIT INTERNAL LINING AS SPECIFIED. : DENOTES "EXTERIOR WALL CLADDING " " CEMINTEL SURROUND: (SELECTED COLOUR - CONFIRM MANUFACTURERS DETAILS FIXED STEEL FRAMING AS PER ENG DETAILS & INSULATION AS SPECIFIED / STUD FRAMING

MALE

MAT

MULTI-PURPOSE

NON BINARY

OFFICE 1

OFFICE 2

PASSAGE

ST1

ST2

ST3

ST4

STAIR

9.1

4.5

42.3

4.7

12.9

12.9

49.9

1.2

7.0

6.7


6.7

9.6

6.3

522.3 m²

LIFT MANUFACTURERS DETAILS.

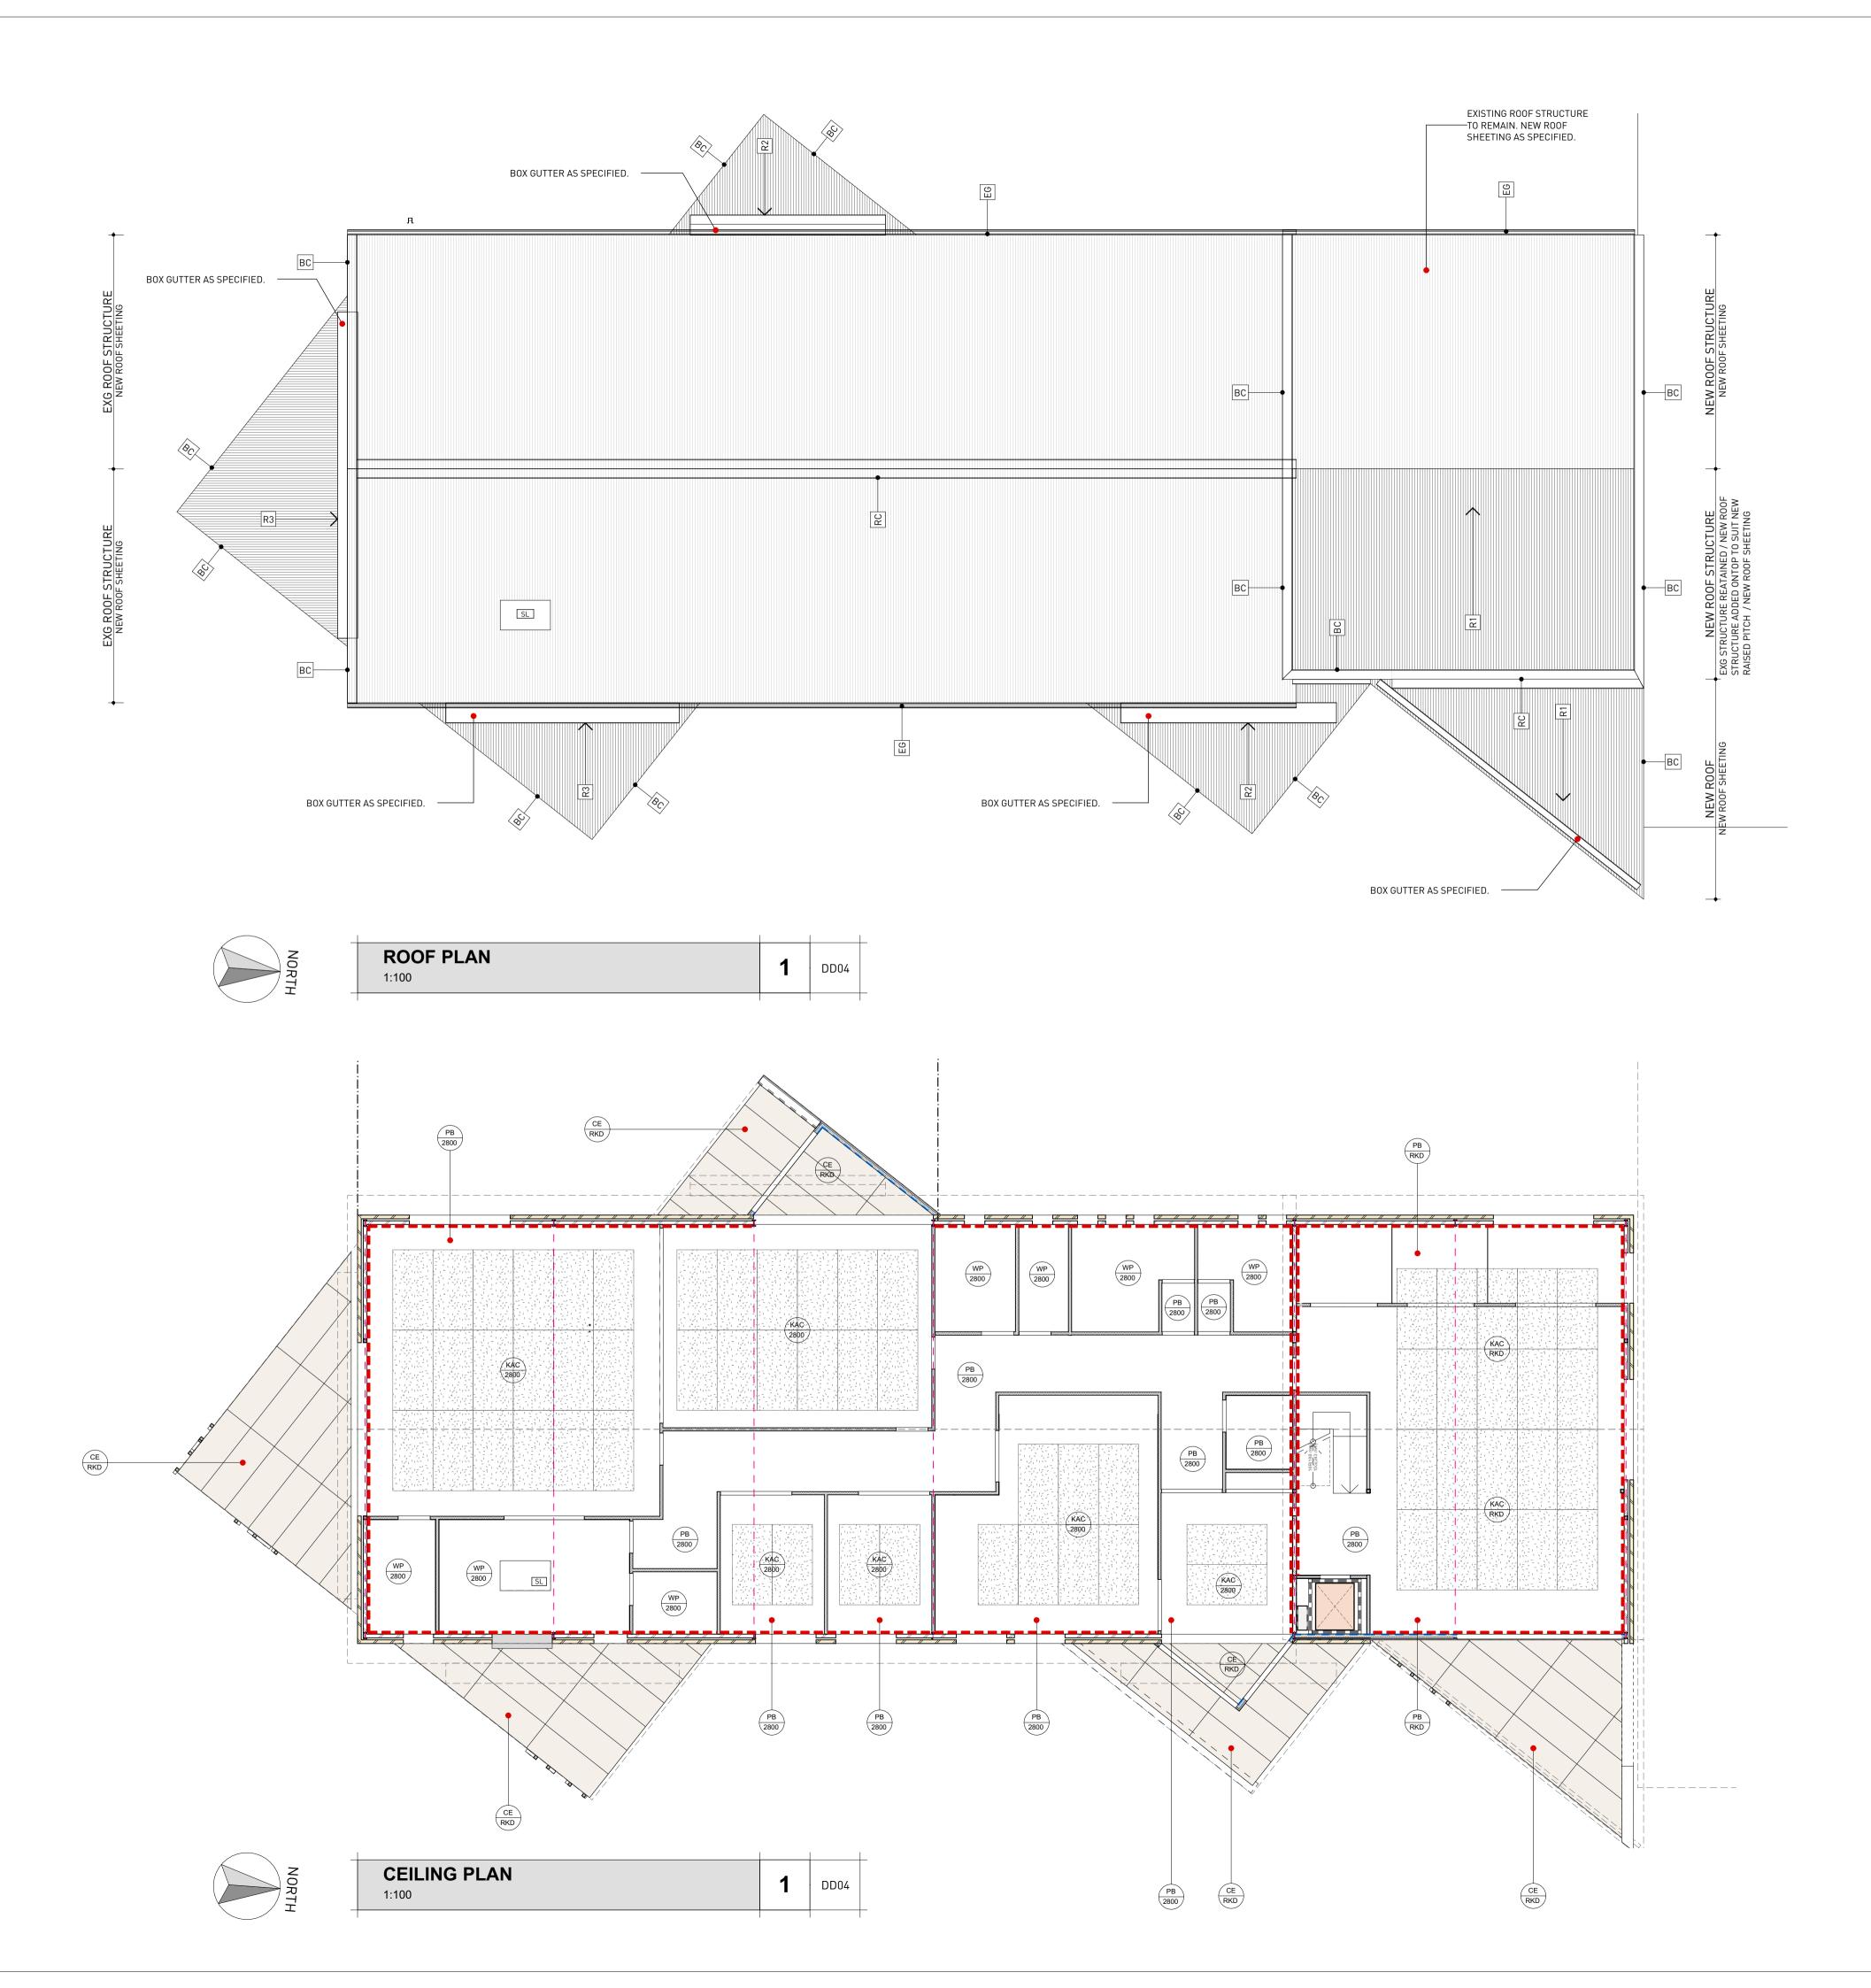

ROOF NOTES:

ROOF LEGEND:

R1 ROOF TYPE 1: MAIN ROOF
LYSAGHT 0.48 BMT TRIMDEK AT 10° ROOF PITCH (COS)
- REFER TO SPECIFICATION FOR SARKING, ROOF SHEETING
INCLUDING ALL PROPRIETARY FIXINGS TO
MANUFACTURERS RECOMMENDATIONS.
COLOUR: SHALE GREY - SOLAR ABSORPTANCE = 0.44

R2 ROOF TYPE 2: LOWER ROOF
LYSAGHT 0.48 BMT TRIMDEK AT 5° ROOF PITCH
- REFER TO SPECIFICATION FOR SARKING, ROOF SHEETING
INCLUDING ALL PROPRIETARY FIXINGS TO
MANUFACTURERS RECOMMENDATIONS.
COLOUR: SHALE GREY - SOLAR ABSORPTANCE = 0.44

R3 ROOF TYPE 2 : LOWER ROOF

LYSAGHT 0.48 BMT TRIMDEK AT 2° ROOF PITCH

- REFER TO SPECIFICATION FOR SARKING, ROOF SHEETING INCLUDING ALL PROPRIETARY FIXINGS TO MANUFACTURERS RECOMMENDATIONS.

COLOUR : SHALE GREY - SOLAR ABSORPTANCE = 0.44

ROOF PLUMBING:
REFER ALSO TO PLAN FOR LOCATIONS OF GUTTERS & DOWNPIPES.
ALL GUTTERING AND DOWNPIPE TO COMPLY WITH BCA AND
AS3500.3 PLUMBING & DRAINAGE, STORMWATER DRAINAGE.
- REFER TO SPECIFICATION FOR PROPRIETARY FIXINGS & DETAILS

● DP COLORBOND DOWNPIPES : 100x75 SQUARE

TO MANUFACTURERS RECOMMENDATIONS

• RC RIDGE CAPPING (COLORBOND)
• EG EAVES GUTTER - STRATCO EDGE GUTTER (SELECTED COLORBOND)

VF VALLEY FLASHING (COLORBOND)

FLASHING (COLORBOND)

BC BARGE CAPPING (COLORBOND)

SL 900 x 1500 VELUX SKYLIGHT

INSULATION NOTES:

INSULATION TO ROOF:

1. CSR BRADFORD "ANTICON 60" R1.3 60MM THICK REFLECTIVE FOIL FACED GLASSWOOL ROOFING BLANKET (OR SIMILAR APPROVED) LAID OVER MAIN ROOF. FIRE PERFORMANCE INDICIES IN ACCORDANCE WITH AS1530: PART 3.

NOTE: PROVIDE BREATHER TYPE SARKING IN ACCORDANCE WITH CEILING MANUFACTURERS RECOMMENDATIONS.

2. CSR BRADFORD "GOLD HI-PERFORMANCE" R6.0 (260MM THICK BATTS OR SIMILAR APPROVED) TO ALL ADMIN AREAS (ALL 2700H CEILINGS).

FIRE PERFORMANCE INDICIES IN ACCORDANCE WITH AS1530: PART

INSULATION TO EXTERNAL WALLS:

METAL CLADDING: AMETALIN THERMAL BREAK + CSR BRADFORD
GOLD R2.5 (90MM) THK INSULATION TO MANUFACTURERS DETAILS
AND SPECIFICATIONS. (CONFIRM EXTERNAL COLOUR WITH
ELEVATIONS SCHEDULE).

INSULATION TO INTERNAL WALLS:
PLASTERBOARD LINED PARTITIONS: CSR BRADFORD
"SOUNDSCREEN" R2.5 90MM THICK WALL BATTS (OR SIMILAR
APPROVED) TO ALL INTERNAL WALLS SHOWN DASHED. FIRE
PERFORMANCE INDICIES IN ACCORDANCE WITH AS1530: PART 3.
NOTE: ALL INSULATION TO BE INSTALLED IN ACCORDANCE WITH
BCA SECTION J1-J8 COMPLIANCE REPORT (PART 3.12)

FLOOR SLAB: CO-ORDINATE WITH ENERGY RATING SLAB TYPE: EXISTING CONCRETE SLAB

CEILING LEGEND:

DENOTES CEILING/SOFFIT LINING TYPE.

DENOTES CEILING/SOFFIT LINING HEIGHT ABOVE FLOOR LEVEL.

RKD= DENOTES RAKED CEILING/SOFFIT AREA

[-]= DENOTES EXISTING CEILING/SOFFIT AREA

*= DENOTES EXISTING CEILING - COS.

NOTE: R6.0 CEILING INSULATION TO MEZZANINE FLOOR AND ABOVE

RECEPTION. SARKING TO MAIN ROOF TO MANUF. DETAILS.

PB = 10MM FLUSH PLASTERBOARD CEILING LINING
FIXED TO CONCEALED GRID SUSPENDED CEILING

SYSTEM OR BATTENS AS REQUIRED.

WP = 10MM WATER RESISTANT FLUSH PLASTERBOARD
CEILING LINING FIXED TO CONCEALED GRID
SUSPENDED CEILING SYSTEM OR BATTENS AS
REQUIRED.

CE = CEMINTEL BARESTONE ORIGINAL SHEETING WITH EXPRESSED JOINTS SOFFIT ON FURRING CHANNELS TO MANUF. DETAILS. PROVIDE SILVER RIVET FIXINGS TO MANUF. DETAILS.

900 x 1500 VELUX SKYLIGHT

KAC = ACOUSTIC CEILING : 13MM THICK KNAUF
STRATOPANEL RANDOM REGULAR RE ACOUSTIC
PLASTERBOARD CEILING WITH CLEANEO
TECHNOLOGY WITH ACCESS PANELS TO TO SUIT
CEILING TYPE TO MANUF. RECOMMENDATIONS.
PROVIDE GREY PROTECTIVE BACKING AND 75MM
RECTANGULAR FIBREGLASS INSULATION ABOVE.
PROVIDE FLUSH PLASTERBOARD SURROUND AS
PER CEILING PLAN (CENTRED IN ROOM).

CORNICES:

 BORAL LINEAR PLASTERBOARD CORNICE AS SPECIFIED SHEET No DD04

Project YOUTH / COMMUNITY CENTRE REFURBISHMENT
Client HAY SHIRE COUNCIL

Location HAY PARK MORGAN STREET, HAY, NSW, 2711

Scale AS SHOWN Issue Date: Design
Rev No: Rev Date: Drawn:

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	ELEVATIONS SCHEDULE:					
TAG NO.	DESCRIPTION		COLOUR			
01	SELECTED METAL DECK ROOFING: MAIN ROOF: 10° PITCH ENTRY ROOF: 5° PITCH LOWER ROOF ADDITIONS: 2° PITCH (SELECTED FLASHINGS & CAPPINGS)		"SHALE GREY"			
02	SELECTED COLORBOND COLORBOND FASCIA (INC. GUTTER)		"DEEP OCEAN"			
03	ALUMINIUM AWNING WINDOWS - SELECTED POWDERCOAT FINISH.		"DEEP OCEAN"			
04	ALUMINIUM FRAMED DOORS - SELECTED POWDERCOAT FINISH. (painted doors to match frame)		"DEEP OCEAN"			
05	CEMINTEL EXTERNAL CLADDING: (WITH COLOUR MATCHED RIVETS TO MANUF. DETAILS)		"BARESTONE: ASH"			
06	EXISTING FACE BRICKWORK		"EXISTING CREAM BRICK"			
07	TRESPA: METEON EXTERNAL CLADDING TO MANUF. DETAILS	93 93 S	"INDIAN TERRA COTTA: NA15"			
80	CEMINTEL EXTERNAL CLADDING: (WITH COLOUR MATCHED RIVETS TO MANUF. DETAILS)		"BARESTONE: ASH"			
09	STRUCTURAL STEEL POST PAINT FINISH		"SELECTED NAVY BLUE"			
10	SELECTED COLORBOND ROLLER DOORS		"DEEP OCEAN"			
11	SELECTED 1M HIGH BALUSTRADE AS SPECIFIED					
12	SELECTED VIRIDIAN GLASS		"EVANTAGE SUPERBLUE"			

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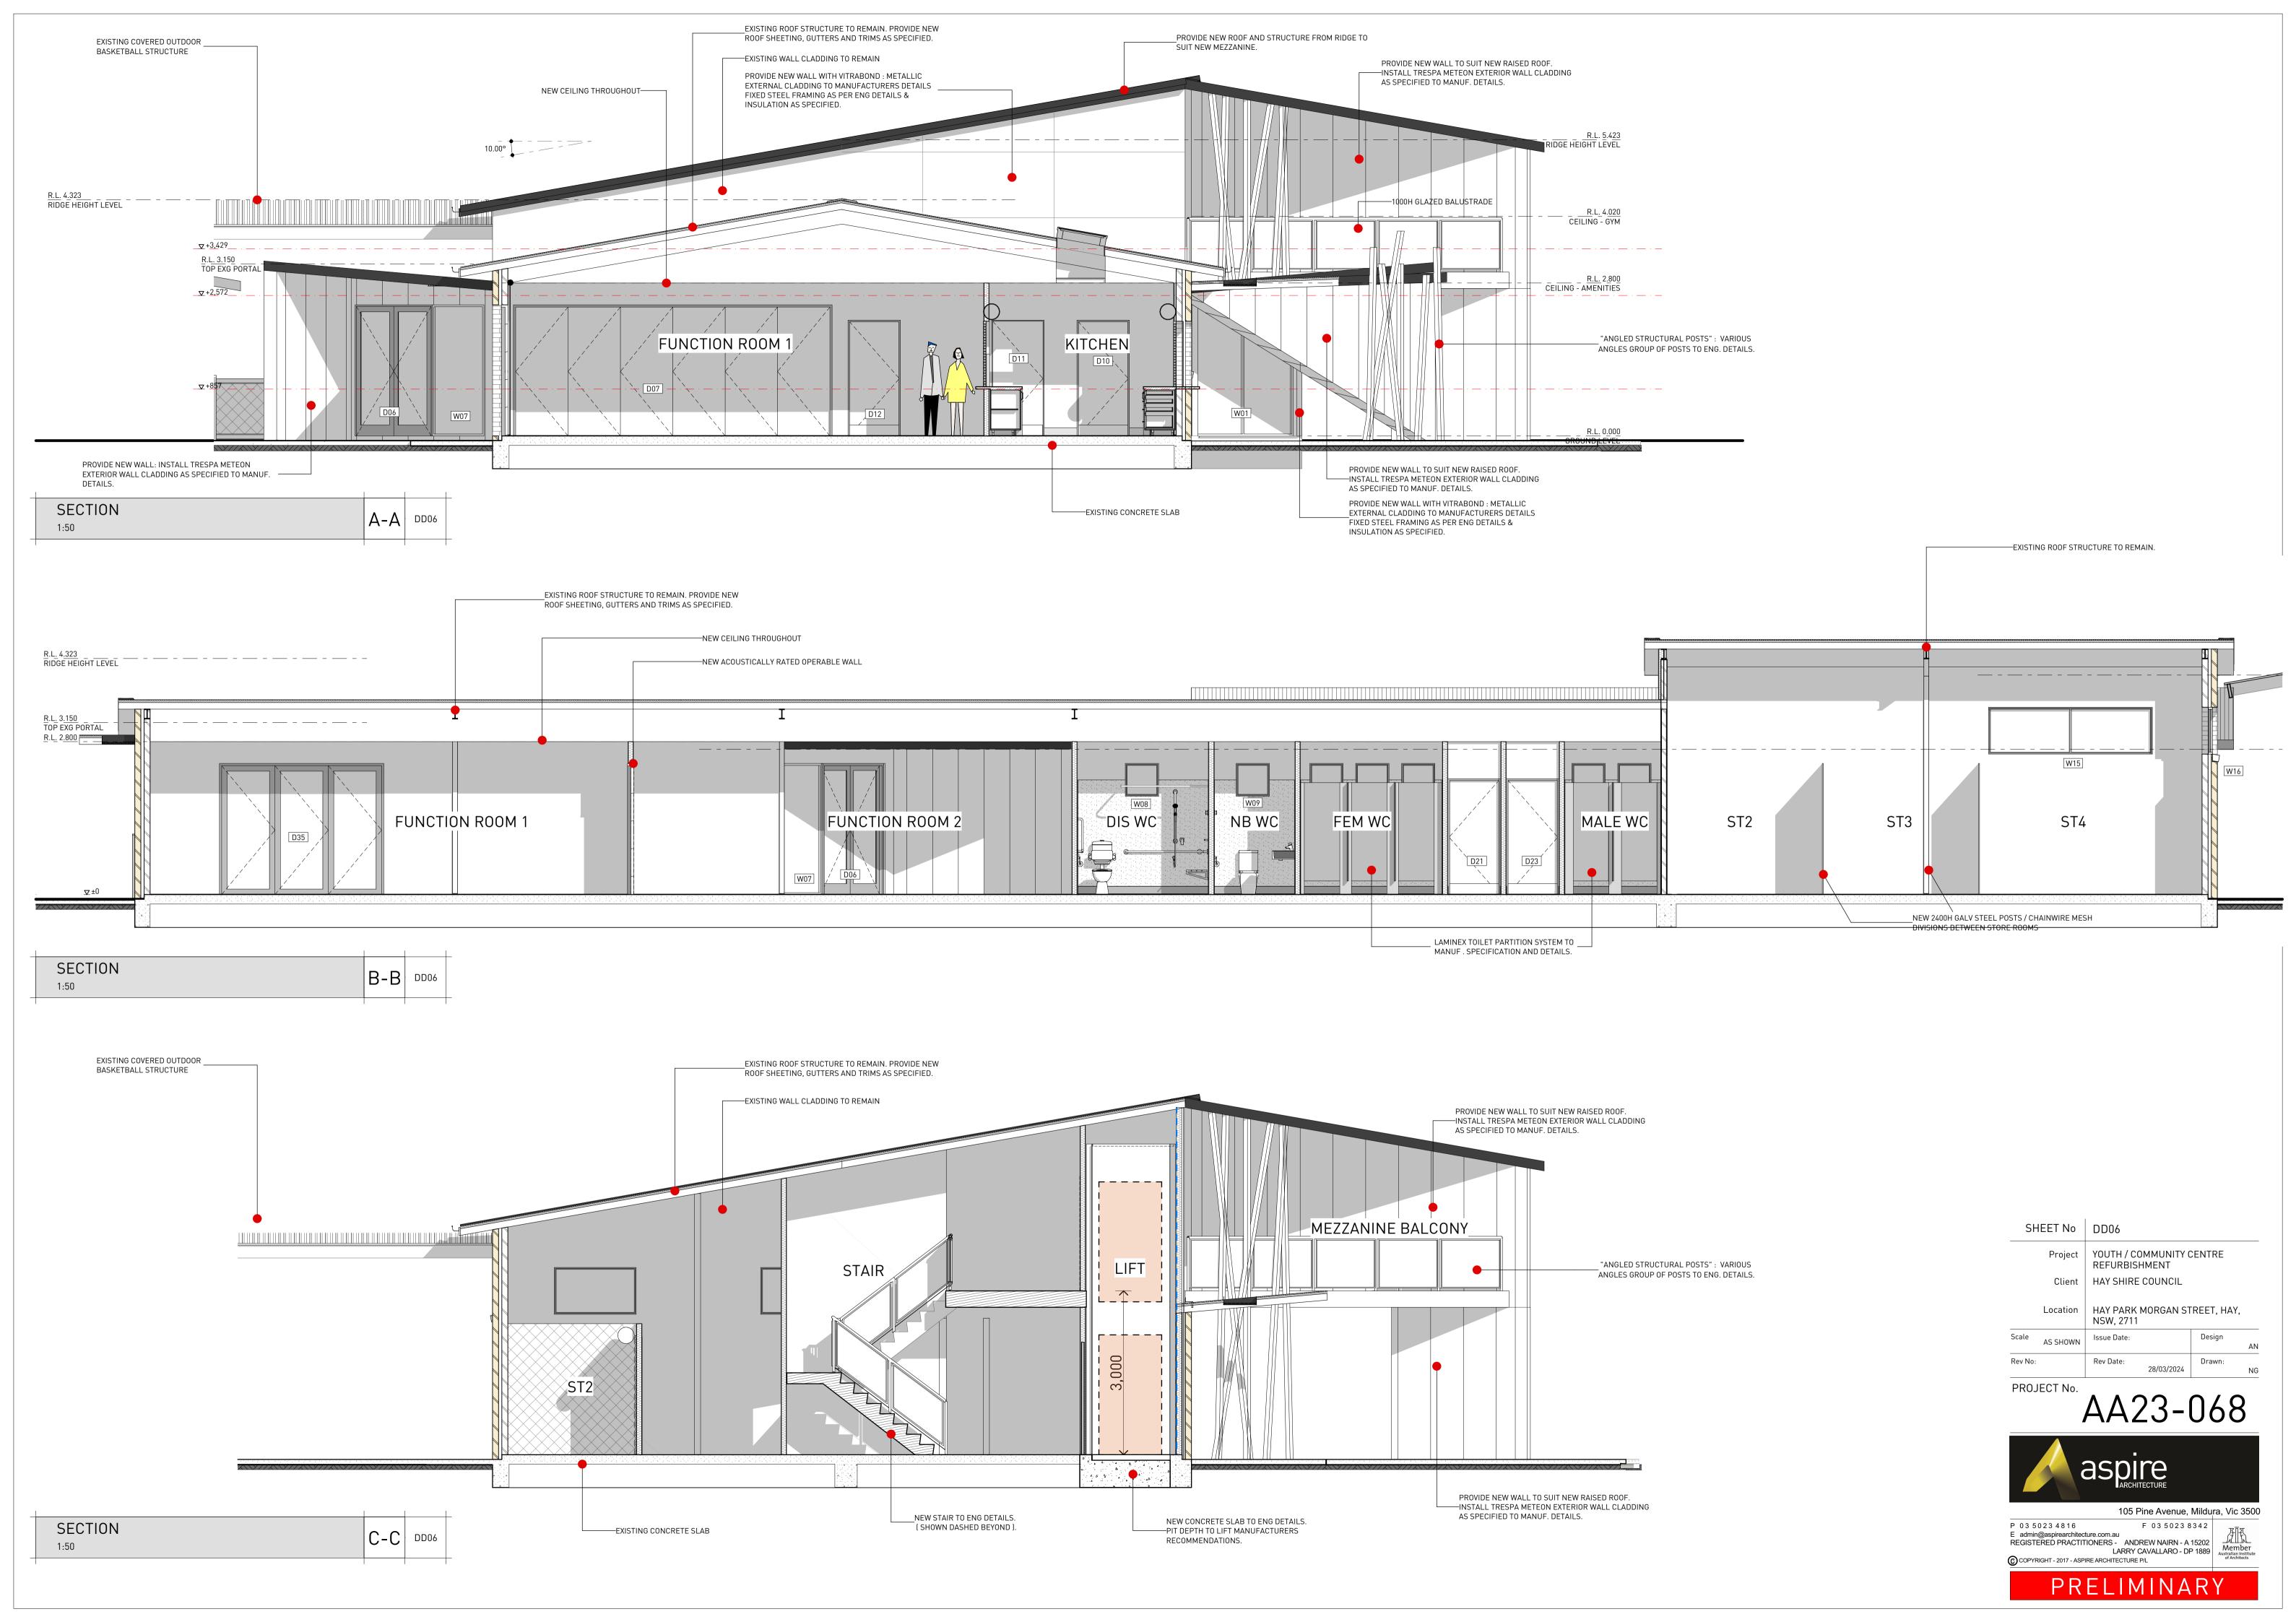
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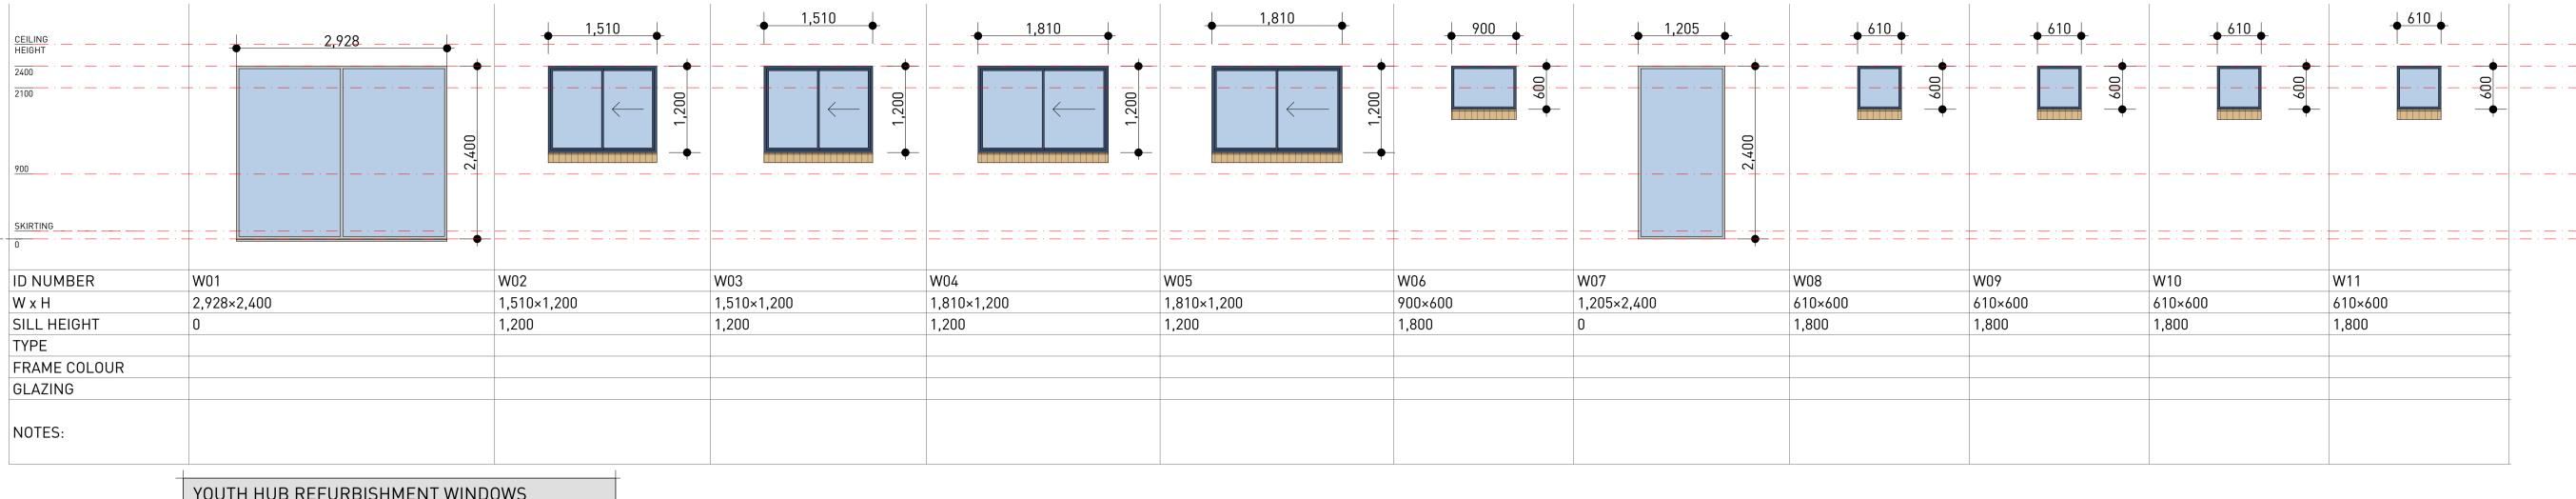


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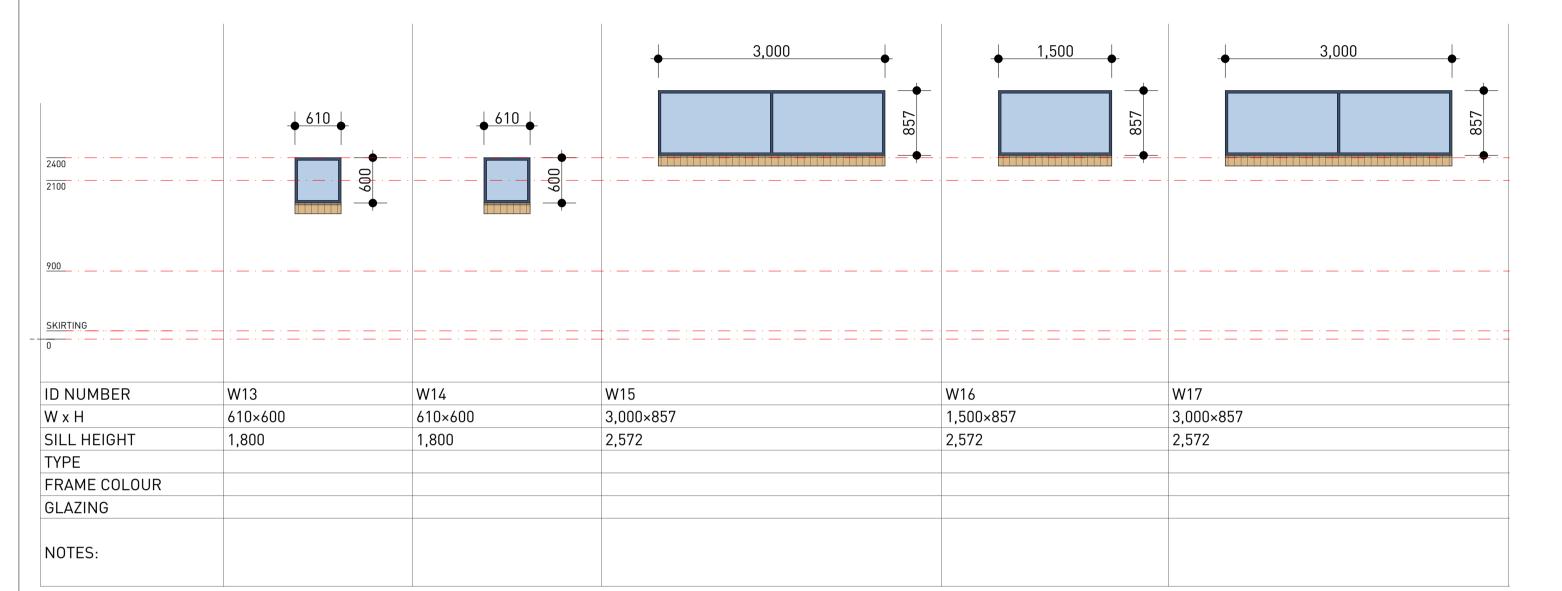







YOUTH HUB REFURBISHMENT WINDOWS

NEW CHANGEROOM WINDOWS



1500 x 900 FIXED VELUX SKYLIGHT TO KITCHEN. CO-ORDINATE TO SUIT EXG ROOF STRUCTURE

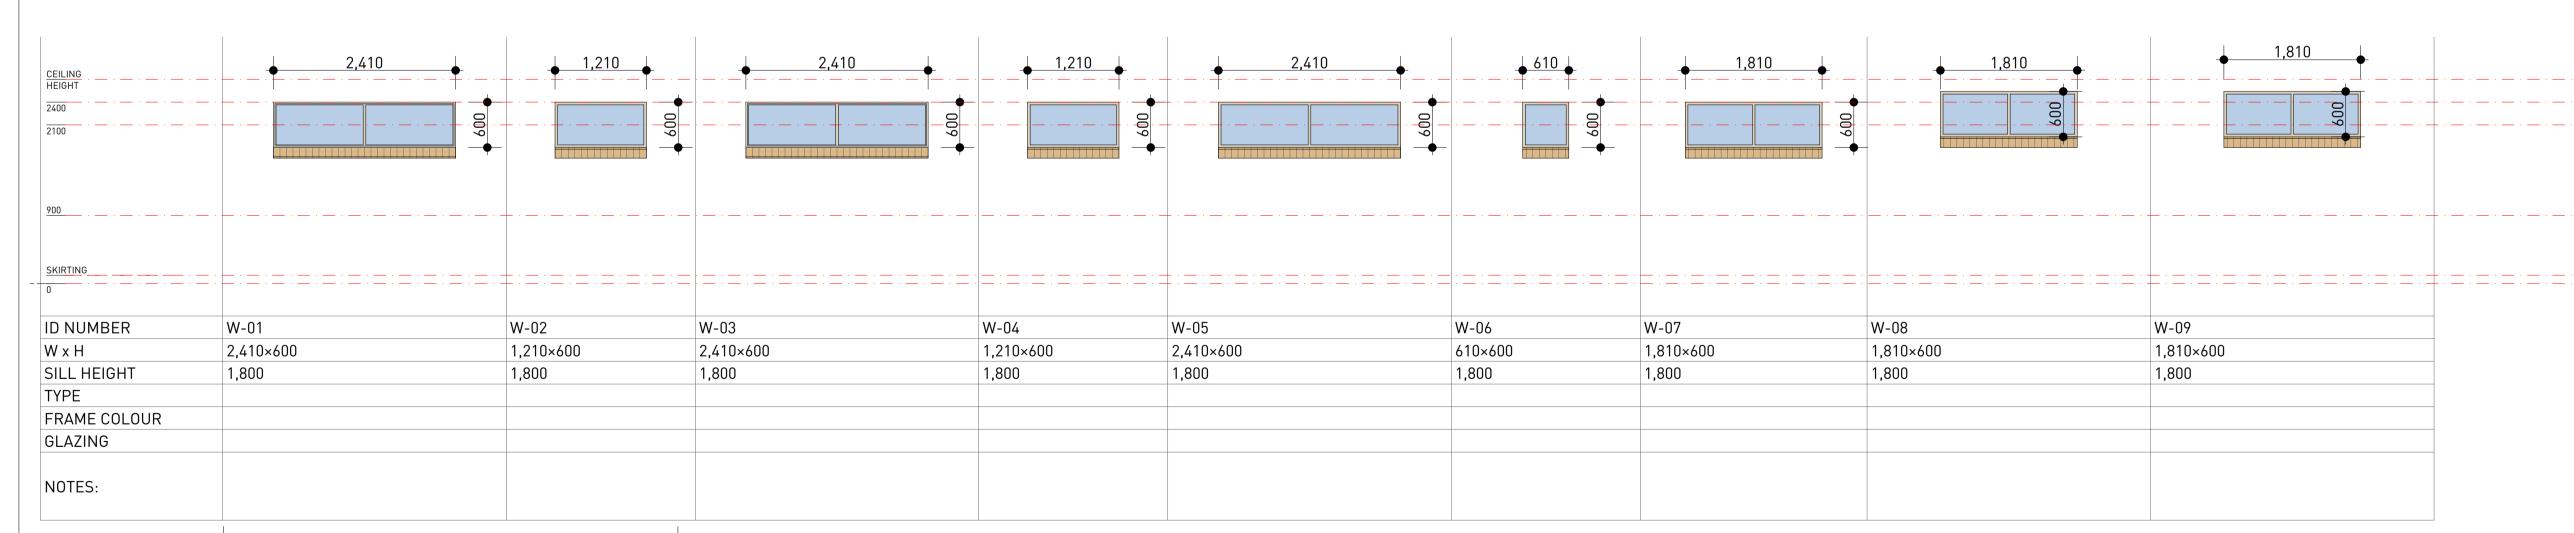

DOOR WINDOW SCHEDULE

GENERAL - REFER TO FLOOR PLAN FOR DOOR SWING / HANDED LOCATIONS - ALL DIMENSIONS TO BE CHECKED ON SITE - ALL NEW EXTERNAL DOORS TO HAVE ALL LEVEL ENTRY

DOORWAYS (NO STEPS) - ALL OPENABLE WINDOWS TO HAVE FLY SCREENS INCLUDED - ALL DOORS TO PROVIDE MIN 850mm CLEARANCE DOORWAY TO COMPLY WITH

AS1428 ACCESSABILITY CODE - ALL TOILET DOORS TO HAVE LIFT OFF HINGES. - PROPRIETOR TO PROVIDE CYLINDER / LOCK MECHANISM AND KEYING SYSTEM. - OPERATION OF LATCHES TO ALL DOORS TO COMPLY WITH BCA D2.21.

ABBREVS. & SYMBOLS F.G DENOTES FIXED GLAZING S.D SLIDING DOOR

HINGED DOOR AWNING WINDOW LOUVRED WINDOW

GLAZING BAND TO AS1288 FOB ACCESS SYSTEM AS SPECIFIED **GLAZING & DOOR NOTES**

ALL RELEVANT DOCUMENTS. ALL EXTERNAL DOORS AND WINDOWS SHALL BE VIEWED FROM OUTSIDE. ALL INTERNAL DOORS AND DOOR/WINDOW SUITES ARE DISPLAYED FOR

DRAWINGS ARE TO BE READ IN CONJUNCTION WITH SPECIFICATION &

INFORMATION PURPOSES & SHALL BE READ IN CONJUNCTION WITH FLOOR PLAN FOR CORRECT VIEWING PROJECTION. REFER FLOOR PLAN FOR LEFT OR RIGHT HAND DOOR SWING. THE FABRICATOR SHALL VERIFY ALL DIMENSIONS ON SITE &

CO-ORDINATE WITH OTHER TRADES PRIOR TO COMMENCEMENT OF FABRICATION.. ALL WINDOWS AND DOORS TO BE IN ACCORDANCE WITH AS2047, AS1288, AS1604 & AS2688. ALL DOOR HANDLES SHALL BE MOUNTED 1000MM A.F.L TO

REFER TO SCHEDULE OF MONETARY SUMS FOR DOOR HARDWARE DETAILS. REFER TO SCHEDULE OF MONETARY SUMS FOR DOOR SIGNAGE

CENTRELINE OF FITTING UNLESS OTHERWISE NOTED.

DETAILS. REFER TO SCHEDULE OF MONETARY SUMS FOR DECORATIVE FILM DETAILS.

11. REFER TO MECHANICAL DRAWINGS FOR INTERNAL DOORS REQUIRING AN UNDERCUT OF CLEAR 20MM FROM BOTTOM EDGE OF DOOR TO FINISHED FLOOR SURFACE IF MECHANICAL ENGINEERS DEEM AIR RELIEF GRILLES NOT REQUIRED OR SUITABLE. 12. IN ACCORDANCE WITH NCC PART D3.3 AND 1428-1-2009, ALL FULL

HEIGHT GLAZING (IN BOTH WINDOWS AND DOORS) SHALL HAVE A 75MM MINIMUM STRIP OF OBSCURE WIDOW FILM INSTALLED ACROSS THE FULL WIDTH OF EACH PANEL. THIS STRIP SHALL BE INSTALLED BETWEEN 900mm AND 1000mm ABOVE FLOOR LEVEL. METAL FRAMED WINDOWS & GLAZING SUITES:

13. WINDOWS & GLAZING SUITES TO BE COMPLETED WITH ALUMINIUM AGLE

TRIMS AND ALL OTHER ITEMS REQUIRED. ALL ANGLES SECTIONS, OR COVER FILLETS SHALL BE MINIMUM 1.6MM THICK ALUMINIUM AND OF DIMENSIONS SUITABLE FOR THE PURPOSE REQUIRED. ALL JUNCTIONS SHALL BE CONSISTENT HAIRLINE JOINT FINISH. WINDOWS INCLUDING ALL ACCESSORIES SHALL BE POWDER COATED TO FUTURE COLOUR SELECTION.

PROVIDE & FIX SILL AND HEAD FLASHINGS TO EACH FRAME AS REQUIRED. SEAL EACH JUNCTION WITH ADJOINING MATERIALS WITH APPROVED SEALANT APPLIED IN ACCORDANCE WITH THE MANUFACTURERS SPECIFICATION. ALL CAPRAL ALUMINIUM DOORS & WINDOWS (EXCEPT CIRCULAR WINDOWS) SHALL BE COMPLETE WITH DEFLECTION HEAD & SLOTTED SUB-SILLS.

PROVIDE HIGH QUALITY FIBREGLASS MESH INSECT SCREENS (BLACK) TO ALL EXTERNAL OPENING WINDOWS. MESH SHALL BE BEADED TO THE FULL PERIMETER AND MADE TAUT WITHOUT BOWING OF THE FRAME.

METAL DOORS & FRAMES:

14. EACH FRAME SHALL HAVE STAINLESS STEEL STRIKER PLATE, SPREADER, RUBBER DOOR BUFFERS, HINGES AS SCHEDULED AND STIFFENING FOR CLOSER AND HINGES. EACH FRAME SHALL BE FITTED IN ACCORDANCE WITH THE MANUFACTURERS SPECIFICATION. MAKE PROVISION FOR FIXING OF HARDWARE SPECIFIED FOR RELEVANT DOORS SETS IN THE DOOR SCHEDULE. ALUMINIUM DOORS AND FRAMES SHALL BE POWDER COATED FINISH TO FUTURE


COLOUR SELECTION. EXTERNAL POWDER COATING:
15. ALL EXTERNAL POWDERCOATING SHALL BE DULUX AUSTRALIA "DURATEC LX" (OR SIMILAR APPROVED) ADVANCED POLYESTER RESIN TYPE CONFORMING WITH PERFORMANCE REQUIREMENTS OF AAMA2604-02. PRODUCT CODE: 905 LINE. COLOUR TO BE SELECTED FROM PEARL RANGE.

INTERNAL POWDER COATING:

16. ALL EXTERNAL POWDERCOATING SHALL BE DULUX AUSTRALIA
"DURALLOY" (OR SIMILAR APPROVED) THERMOSETTING POWDER COATING MEETS


AND/OR EXCEEDS REQUIREMENTS OF AS3715, BS6496. PRODUCT CODE: 272 LINE

COLOUR TO BE SELECTED FROM PEARL RANGE.

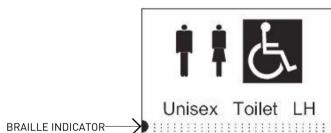

TYPICAL DISABLED WC SIGNAGE

- SIGNAGE TO BE MOUNTED ON DOOR BETWEEN 1200-1600MM AFL - A BRAILLE INDICATOR SHALL BE USED TO IDENTIFY THE FIRST LINE OF BRAILLE IN CASES OF MULTIPLE LINES OF TEXT. THE SIGN SHALL DISPLAY A UNISEX ACCESSIBLE TOILET WITH LEFT HAND (LH) OR RIGHT HAND (RH) TRANSFER. SIGNAGE SHALL HAVE RAISED TEXT AND BRAILLE TOGETHER WITH RAISED

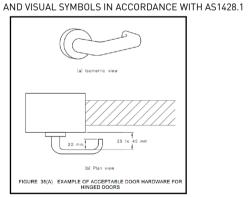

TYPICAL DOOR HANDLE HARDWARE TO ALL HINGED DOORS

SHEET No DD09 Project | YOUTH / COMMUNITY CENTRE REFURBISHMENT

Client | HAY SHIRE COUNCIL

Location | HAY PARK MORGAN STREET, HAY, NSW, 2711

AS SHOWN 28/03/2024


PROJECT No



105 Pine Avenue, Mildura, Vic 3500 P 03 5023 4816 F 0350238342 REGISTERED PRACTITIONERS - ANDREW NAIRN - A 15202







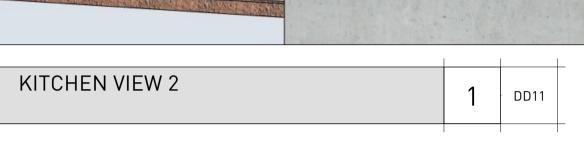






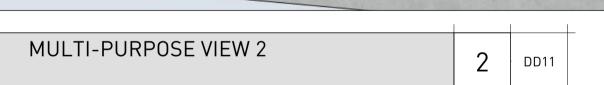

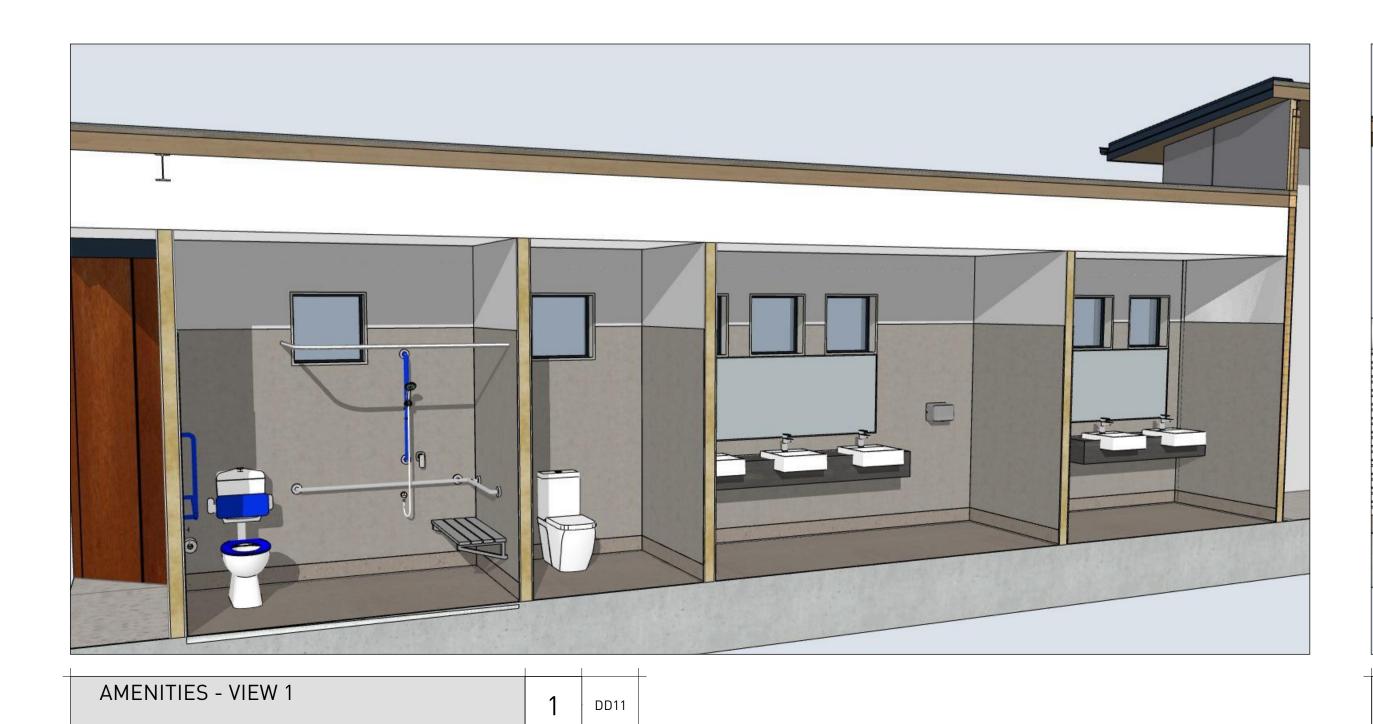

1 DD11



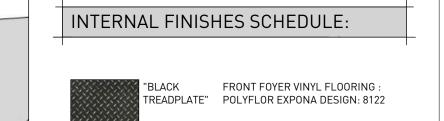

FOYER ENTRY MAT: OBEX MILLIKEN: CUT THREAD

FUNCTION ROOMS AND HALLWAY

VINYL FLOORING : MILIKEN OPEN FRAGMENTS:

CARPETED ROOMS : MILIKEN LARIMAR:

WET AREA VINYL: POLYFLOR POLYSAFE QUATRO 5762 (COVED)

POLYTEC: PARTITIONS : 13MM COMPACT "GREY CEMENT" LAMINATE TO MANUF. DETAILS WALL PANELS : 5MM COMPACT LAMINATE TO MANUF. DETAILS

DOORS: 13MM COMPACT LAMINATE "HABITAT" TO MANUF. DETAILS

POLYTEC: VANITY BENCH : 13MM COMPACT BOTEGA OAK" LAMINATE TO MANUF. DETAILS

POLYTEC: KITCHEN BENCH : 13MM COMPACT "GREY CEMENT" LAMINATE TO MANUF. DETAILS

KITCHEN DOORS AND PANELS: 13MM COMPACT LAMINATE TO MANUF. DETAILS

DULUX: SKIRTINGS : TASMANIAN UAK PAINT FINISH TO MATCH WALLS)

SHEET No DD11 Project YOUTH / COMMUNITY CENTRE REFURBISHMENT Client HAY SHIRE COUNCIL Location HAY PARK MORGAN STREET, HAY, NSW, 2711 AS SHOWN | Issue Date:

PROJECT No. AA23-068




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E admin@aspirearchitecture.com.au
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1 DD12



4 DD12



5 DD12

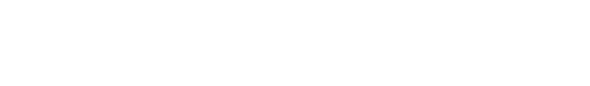



AA23-068



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